
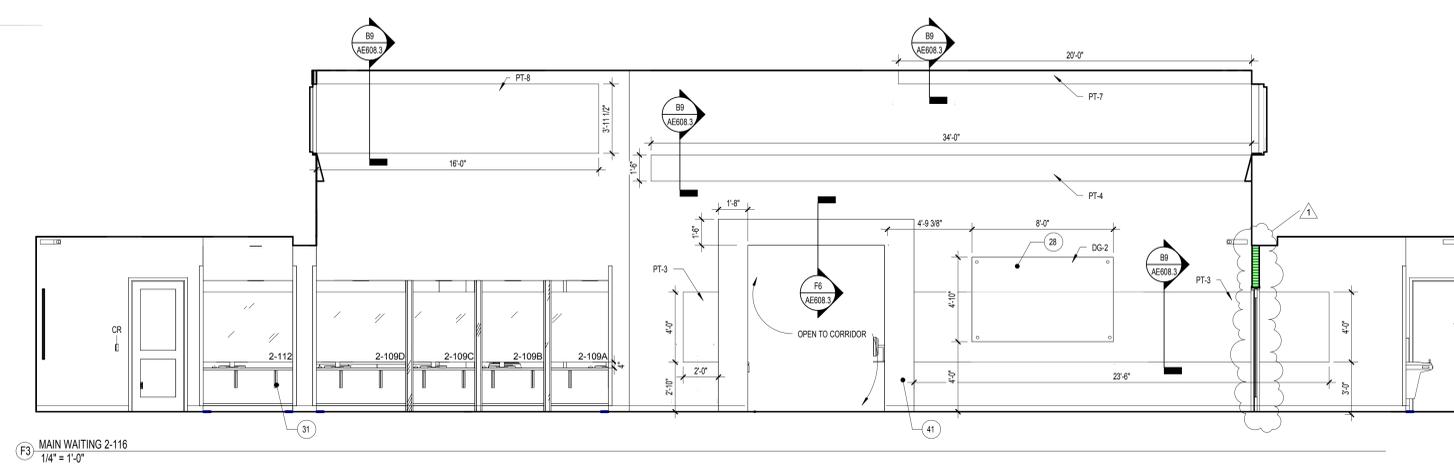
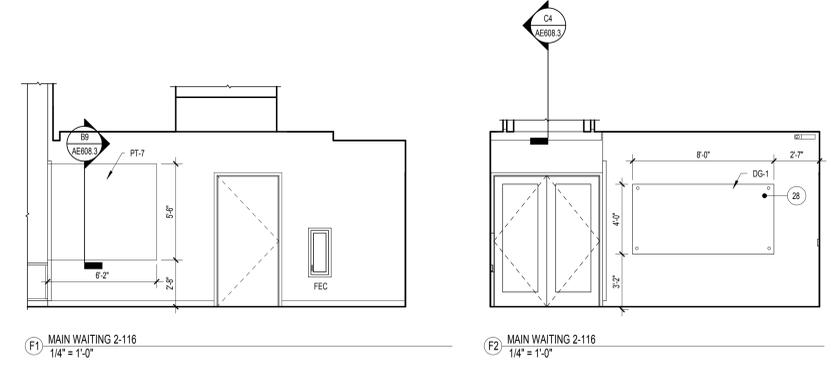
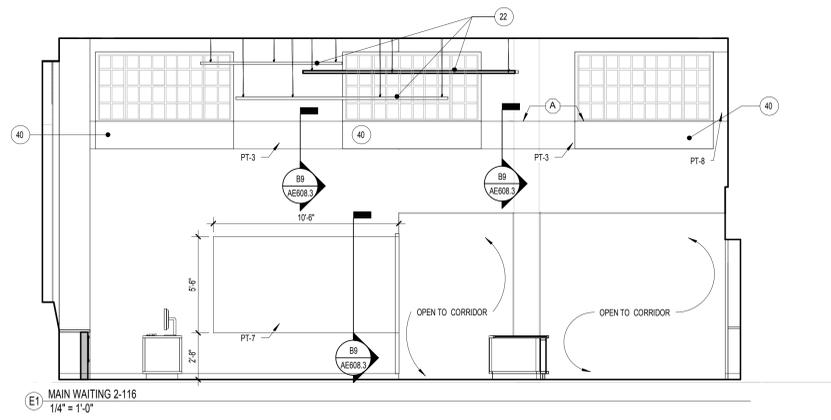
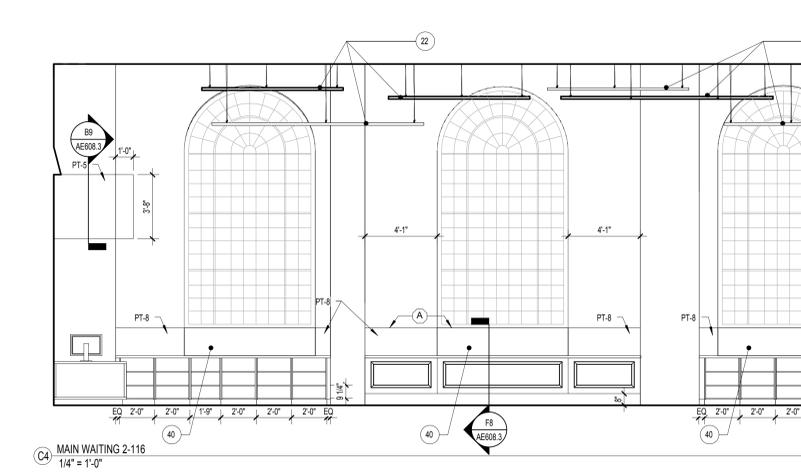
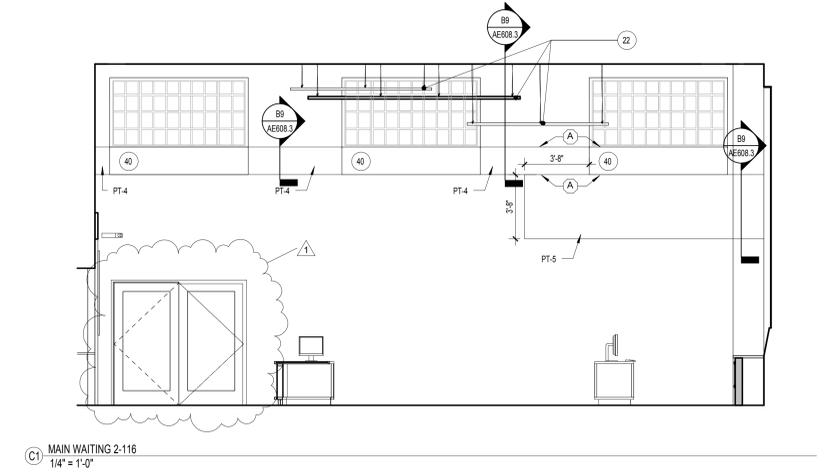
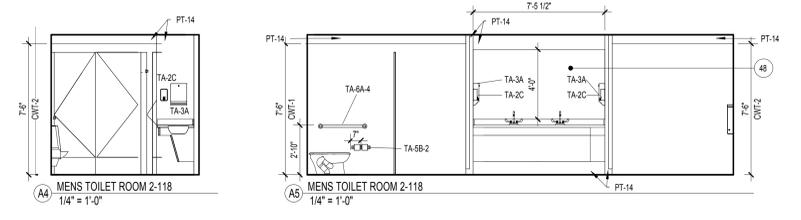


INTERIOR ELEVATION KEYNOTES

- 1 PLASTIC LAMINATE FILLER PANEL.
- 2 FINISH EXPOSED SIDE OF BASE CABINET WITH PLASTIC LAMINATE.
- 3 PLASTIC LAMINATE END PANEL.
- 4 1" PLASTIC LAMINATE SUPPORT LEG.
- 5 SLOPED PLASTIC LAMINATE FASCIA PANEL ABOVE WALL CABINET, TYPICAL.
- 6 PLASTIC WALL PROTECTION.
- 7 CORNER GUARD.
- 8 HANDRAIL, MOUNT TOP AT 2'-10" A.F.F., U.N.O.
- 9 BUMPER GUARD.
- 10 ARCHITECTURAL CONCRETE BENCH BELOW STAIRS. REFER TO DETAIL BR5462.
- 11 FABRIC WRAP TACK BOARD.
- 12 4" HIGH SOLID SURFACE BACK AND SIDE SPLASHES.
- 13 SOLID SURFACE WINDOW SILL.
- 14 WALL OPENING TO BE SCORED TO REFRIGERATOR BOX.
- 15 SCHEDULED BASE AT RECESSED TOE KICK.
- 16 SCHEDULED BASE.
- 17 GYPSUM WALL BOARD SOFFIT.
- 18 CONTINUOUS WIRE MOLD, REFER TO ELECTRICAL DRAWINGS.
- 19 CONTINUOUS "J" HANGER.
- 20 SEGMENTED REMOVABLE ACCESS PANEL.
- 21 WALL SCOSCE.
- 22 FLOATING CEILING, REFER TO FINISH PLAN FOR MORE INFORMATION.
- 23 PROVIDE LOCKS ON CABINETS AND DRAWERS AS NECESSARY.
- 24 SOLID SURFACE POLYMER END PANEL.
- 25 GKD MESH RAILING WITH CHESTNUT HANDRAIL, OR APPROVED EQUAL. REFER TO SHEET AE402 FOR DETAILS.
- 26 1/4" NON-VENTED METAL REVEAL.
- 27 1" REVEAL IN CONCRETE WALL.
- 28 LAMINATE AND TEMPERED GLASS.
- 29 METAL SHELVES ON ADJUSTABLE BRACKETS WITH SLOPED TOP.
- 30 CUBICLE CURTAIN AND TRACK.
- 31 METAL SUPPORT BRACKET.
- 32 CORK BOARD, THERMO SCIENTIFIC HAMILTON MAX LAB SYSTEM, OR APPROVED EQUAL.
- 33 EPOXY RESIN WORK SURFACE, THERMO SCIENTIFIC HAMILTON MAX LAB SYSTEM, OR APPROVED EQUAL.
- 34 1/2" METAL SHELVING ON ADJUSTABLE BRACKETS, THERMO SCIENTIFIC HAMILTON MAX LAB SYSTEM, OR APPROVED EQUAL.
- 35 METAL BASE CABINET WITH 4 INCH TOE KICK, THERMO SCIENTIFIC HAMILTON MAX LAB SYSTEM, OR APPROVED EQUAL.
- 36 SUSPENDED METAL WALL CABINET WITH SLIDING GLASS DOORS, THERMO SCIENTIFIC HAMILTON MAX LAB SYSTEM, OR APPROVED EQUAL.
- 37 METAL BASE CABINET.
- 38 SINK PROVIDED BY CASEWORK MANUFACTURER. FAUCET WITH EMERGENCY EYEWASH FIXTURE. REFER TO PLUMBING FIXTURE SCHEDULE.
- 39 OPENING IN EXISTING BRICK WALL FOR PENETRATION OF HVAC. REFER TO MECHANICAL DRAWINGS FOR DUCT SIZES AND LOCATIONS.
- 40 TERRA COTTA SILL.
- 41 TERRA COTTA PORTAL.
- 42 TASK LIGHTING.
- 43 SUSPENDED METAL WALL CABINET WITH SLIDING DOORS, THERMO SCIENTIFIC HAMILTON MAX LAB SYSTEM, OR APPROVED EQUAL.
- 44 METAL MOBILE HEIGHT-ADJUSTABLE TABLE WITH LOWER SHELF, THERMO SCIENTIFIC HAMILTON MAX MOBILE SYSTEM, OR APPROVED EQUAL. 300 LBS LOAD CAPACITY.
- 45 ISOLATED TABLE PER USE OF MICROSCOPE. REFER TO ENLARGED PLAN LAB DWG#211.1 FOR LOCATIONS.
- 46 ADJUSTABLE PLASTIC LAMINATE SHELVES. ALL (6) SIX FACES TO BE LAMINATED PL-1, U.N.O.
- 47 RECESSED LIGHT FIXTURES, REFER TO REFLECTED CEILING PLAN FOR INFORMATION.
- 48 PLEXIGLASS SHEET ACRYLIC MIRROR.
- 49 CONTINUOUS METAL BASE BY LOCKER MANUFACTURER.
- 50 METAL FILLER PANEL BY LOCKER MANUFACTURER.
- 51 CONTINUOUS METAL SLOPED TOP BY LOCKER MANUFACTURER.

GENERAL NOTES

1. REFER TO OVERALL ARCHITECTURAL PLAN FOR ARCHITECTURAL KEYNOTES.

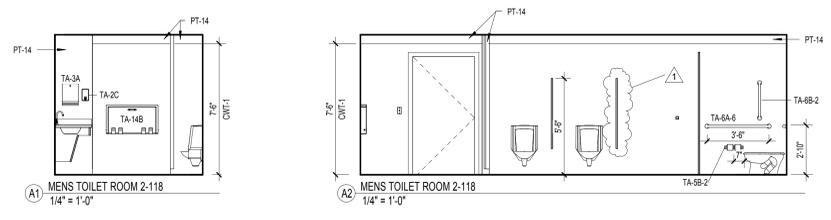

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CONSULTANTS:

<p>Architects-Interiors ARRAY healthcare facilities solutions</p> <p>2520 Renaissance Blvd Suite 110 King of Prussia, PA 19406 Tel: (610) 270-5599 Fax: (610) 270-5995</p>	<p>Structural Engineer WZG</p> <p>180 W. Ridge Pike Limerick, PA 19468 Tel: (214) 329-5559</p>	<p>MEP Engineer APOGEE Consulting Group, Inc.</p> <p>6325 Woodside Court Columbia, MD 21046 Tel: (919) 858-7420</p>	<p>Fire Protection Harrington Group, Inc.</p> <p>7508 E. Independence Blvd Suite 116 Charlotte, NC 28227 Tel: (704) 531-9077 Fax: (704) 567-7087</p>
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PROJECT MANAGER:

Bray Mooney Consulting

410 East 21st Street
Chester, PA 19013
Tel: (215) 518-0864
Fax: (484) 428-1547

Project Number: 3545
Scale: As indicated

Drawing Title: ENLARGED INTERIOR ELEVATIONS - MAIN WAITING

Project Title: BUILDING 3 OUTPATIENT MEDICAL SUITES AND LAB

VA Project Number: 542-09-121
Building Number:

Office of Facilities Management

Approved: Project Director

Location: 1400 Black Horse Hill, Coatesville, PA

Drawing Number: AE203.2

Department of Veterans Affairs

Date: 04-23-2012
Checked: WC
Drawn: BG
Dwg. 20 of 79

three inches = one foot
one and one half inches = one foot
one inch = one foot
three quarters inch = one foot
one half inch = one foot
three quarters inch = one foot
one half inch = one foot
three eighths inch = one foot
one quarter inch = one foot
one eighth inch = one foot
one eighth inch = one foot